City of Plymouth Plan Commission

Members: Please notify us if you are unable to attend the meeting.

Chairman; Mayor Don Pohlman

Members:
Carole O'Malley
Jeremy Schellin
Greg Hildebrand
Ron Nicolaus
Scott VanNorwick
Randy Schwoerer

The City of Plymouth Plan Commission will have a meeting on Thursday, **February 2, 2023 at** 6:00 PM in **Room 305**, City Hall, and Plymouth, WI.

The agenda will be as follows:

- 1.) Approval of Minutes from January 5, 2023.
- 2.) Site Plan seeking approval; (area of 2587 Eastern Ave) Braveheart Development, David Pedelty dba; Scooter's Coffee (enclosure)
- 3.) Site Plan seeking approval; Lot corner of Appleton St and E. Clifford St. 12 unit apartment building. VIK Holdings/ABACUS Architects. (enclosure)
- **4.)** Communication Letters, E-mails, or reports Related to the Plan Commission (Chairman, Secretary, Plan Commission Members, City of Plymouth Staff/Alderpersons)

It is possible that members of and possibly a quorum of members of other governmental bodies of the municipality may be in attendance at the above stated meeting to gather information. No action will be taken by any governmental body at the above stated meeting other than the governmental body specifically referred to above in this notice. Please note that, upon reasonable notice, efforts will be made to accommodate the needs of disabled individuals through appropriate aids and services. For additional information or to request this service, contact City of Plymouth ADA Coordinator Leah Federwisch, located in the Plymouth Utilities office at 900 County Road PP, Plymouth, WI or call 920-893-3853

City of Plymouth 128 Smith St. – PO Box 107 Plymouth, WI 53073-0107



Telephone: (920) 893-3741 Facsimile: (920) 893-9590

e-mail: inspectorpete@plymouthgov.com

January 6, 2022

Members present: Chairman Don Pohlman, Carole O'Malley, Jeremy Schellin, Greg Hildebrand, Ron Nicolaus, Scott VanNorwick, Randy Schwoerer

Staff Present; Administrator Tim Blakeslee

The Plan Commission meeting was called to order by Chairman Pohlman at 18:00 hrs.

Roll Call: All members present.


- 1.) Approval of Minutes from December 1, 2022. Motion to approve minutes made by O'Malley and seconded by Nicolaus. All voted aye to approve.
- **2.) Discussion and possible action:** 125 Highland Ave, Plymouth High School proposing the construction of an 8' x 8' accessory structure to be placed at field east of Horizon School. Beau Biller from Plymouth School District was present and explained the ticket boot placement and design. This will be placed and service the soccer fields east of the Horizon School. Motion to approve made by Hildebrand and seconded by Nicolaus. All voted aye to approve.
- **3.) Discussion and possible action:** 1510 Pilgrim Road, David Marshall, dba Marshall Masonry proposing a second driveway to building. D. Marshall. Marshall explained that they [his company] have been utilizing the single driveway backing trailers in. The second driveway would allow them to drive through load and unload. Motion to approve was made by Jeremy Schellin, second by Nicolaus. On the roll all voted yes to approve.
- 4.) **Discussion and no action:** Downtown Design Strategy Document. Bay Lakes/Admin Blakeslee. Brandon Robinson from Bay Lakes reviewed the scope and purpose of the proposed Design Strategy. Members and Audience participated in sharing thoughts and questions. No action taken.

Communication – Letters, E-mails, or reports Related to the Plan Commission. Nothing was brought forward.

Motion to adjourn made by Hildebrand and seconded by Schwoerer. 6:55 PM

Respectfully Submitted,

Pete Scheuerman Secretary

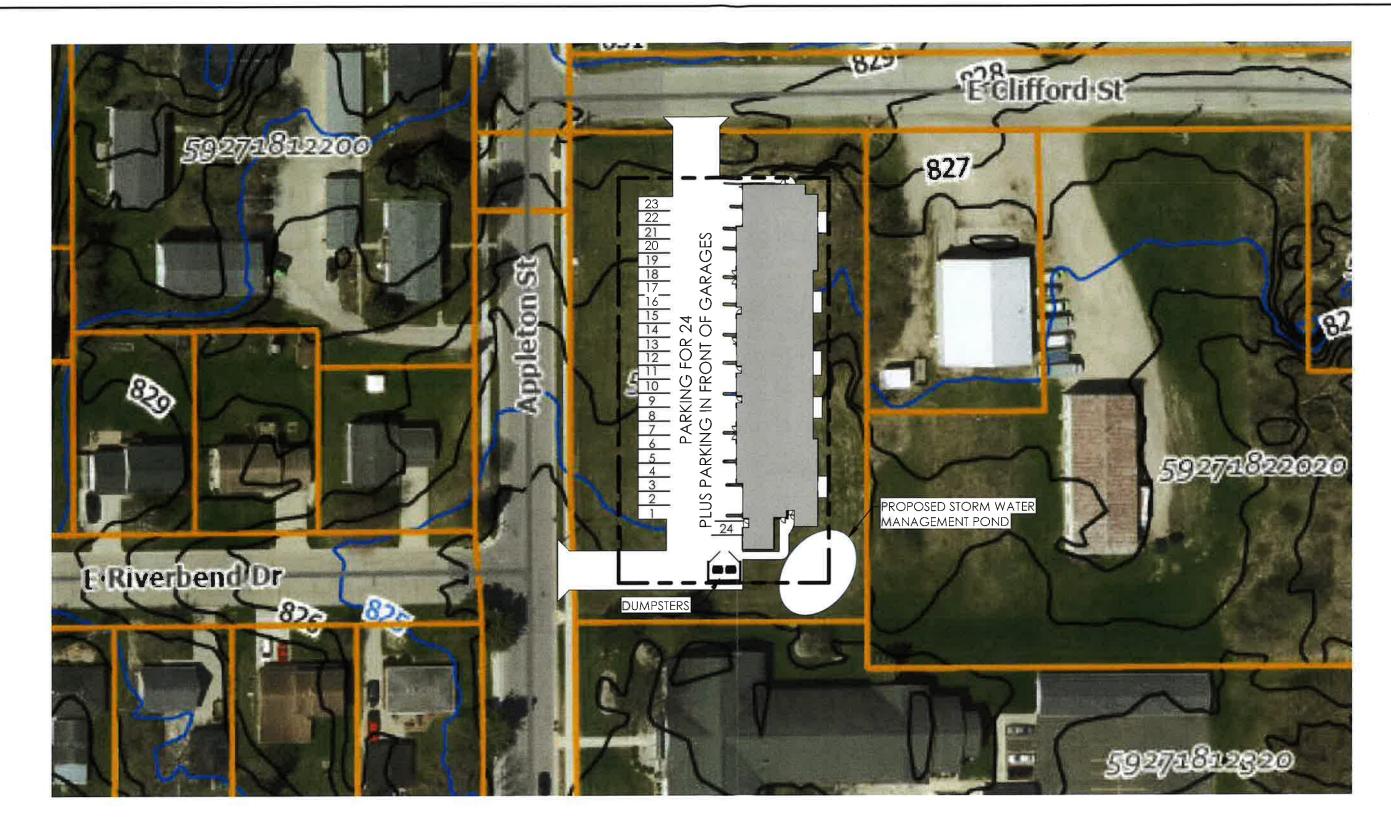

01/23/2022

NEW CONSTRUCTION


ANIL YEPURI 12 UNIT APARTMENT BUILDING SCALE: 1" = 60'-0"

PLYMOUTH, WI PROJ. NO. 2022-135







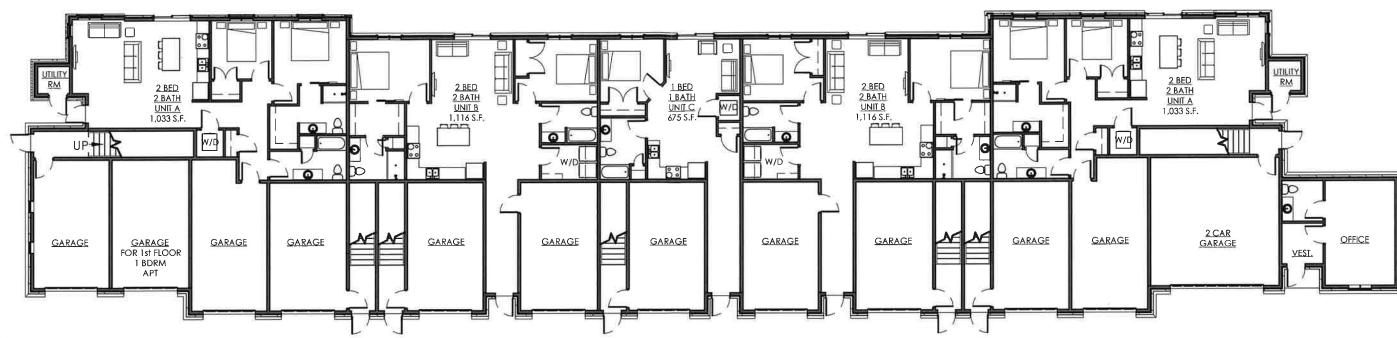



01/23/2022


NEW CONSTRUCTION

ANIL YEPURI 12 UNIT APARTMENT BUILDING

PLYMOUTH, WI PROJ. NO. 2022-135

FIRST FLOOR AREA = 10,788 SQFT TOTAL AREA = 18,866 SQFT NFPA 13R SPRINKLER SYSTEM KNOX RAPID ACCESS SYSTEM



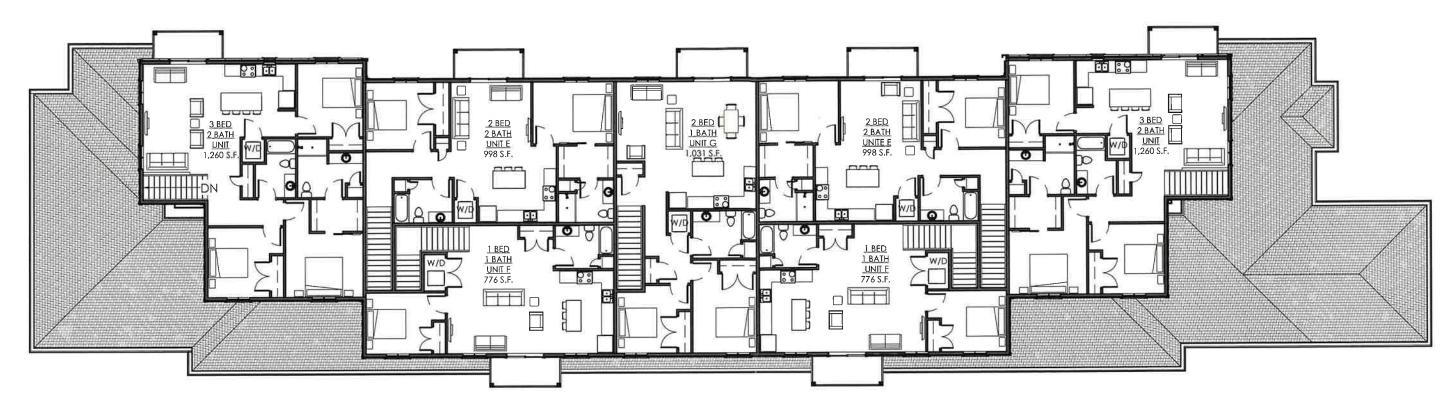




01/23/2022

NEW CONSTRUCTION

ANIL YEPURI 12 UNIT APARTMENT BUILDING

PLYMOUTH, WI SECOND FLOOR AREA = 8,078 SQFT TOTAL AREA = 18,866 SQFT NFPA 13R SPRINKLER SYSTEM KNOX RAPID ACCESS SYSTEM



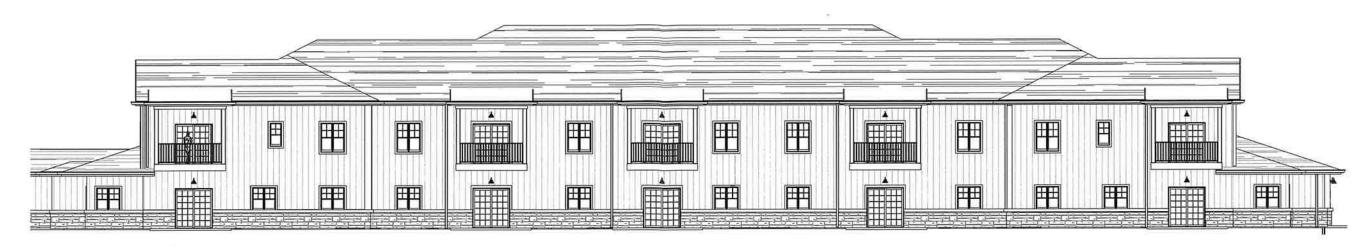

EAST ELEVATION

SCALE: 1/16" = 1'-0"



WEST ELEVATION

SCALE: 1/16" = 1'-0"

01/23/2022

NEW CONSTRUCTION

ANIL YEPURI 12 UNIT APARTMENT BUILDING

PLYMOUTH, WI PROJ. NO. 2022-135





NORTH ELEVATION

SCALE: 1/16" = 1'-0"



SOUTH ELEVATION

SCALE: 1/16" = 1'-0"

01/23/2022 NEW CONSTRUCTION

ANIL YEPURI 12 UNIT APARTMENT BUILDING

PLYMOUTH, WI PROJ. NO. 2022-135





ANIL YEPURI 12 UNIT APARTMENT BUILDING

PLYMOUTH, WI PROJ. NO. 2022-135





ANIL YEPURI 12 UNIT APARTMENT BUILDING

PLYMOUTH, WI PROJ. NO. 2022-135





ANIL YEPURI 12 UNIT APARTMENT BUILDING

PLYMOUTH, WI PROJ. NO. 2022-135







ANIL YEPURI 12 UNIT APARTMENT BUILDING

PLYMOUTH, WI PROJ. NO. 2022-135



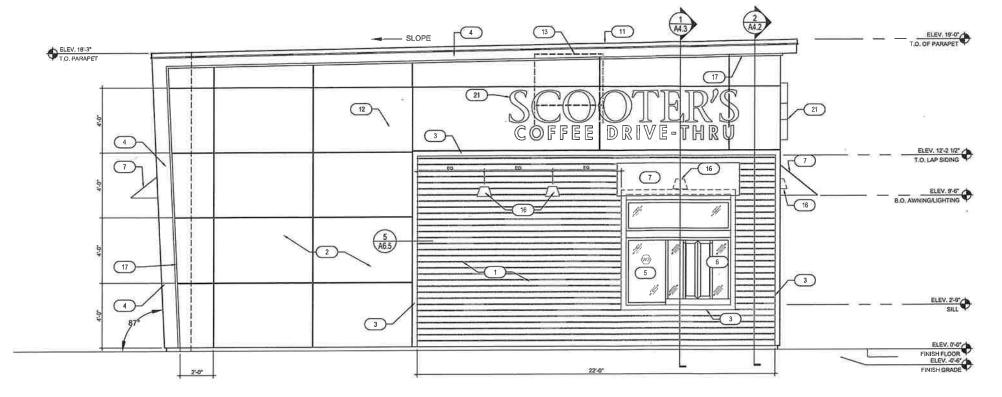

2 EXTERIOR ELEVATIONS EAST

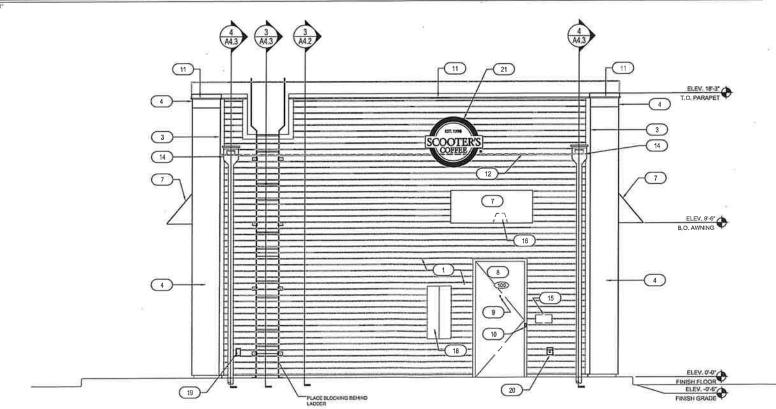

EXTERIOR ELEVATIONS SOUTH

KEYNOTES



- LP SMART LAP SIDING CEDARMILL 6-1/4", SEE LP SMART SIDING DETAIL SHEET A6,5 COLOR: SHERWIN WILLIAMS SW6992 INKWELL EGGSHELL FINISH
- LP SMART SIDING REVEAL PANEL SYSTEM WZ10 SMOOTH FINISH, SEE LP SMART SIDING DETAIL SHEET A6,5 COLOR: SW 1015 SKYLINE STEEL
- 3 1/2" LP SMART SIDING TRIM, SEE LP SMART SIDING DETAIL SHEET A6.5 -COLOR: SHERWIN WILLIAMS SW6992 INKWELL EGGSHELL FINISH
- 4. 20 GAUGE METAL ACCENTS AND SOFFITS COLOR: BLACK
- 5. INSULATED DARK BRONZE ALUMINUM WINDOWS WITH DUAL PANE TEMPERED GLASS
- 6. QUICKSERVE 48X48 WINDOW COLOR: DARK BRONZE
- 7. AWNING BY OTHERS COLOR: RED
- INSULATED HOLLOW METAL DOOR AND FRAME COLOR: SHERWIN WILLIAMS SW6992 RIKWELL EGGSHELL FINISH
- 9, PEEP HOLE, BY DOOR MANUFACTURER
- 10. DOOR BELL
- 11. 20 GUAGE METAL PARAPET CAP
- 12. LINE OF ROOF BEYOND
- 13. ROOF TOP UNIT BEYOND, SEE MECHANICAL DRAWINGS
- 14, ROOF SCUPPER AND DOWNSPOUT, SEE DETAIL 8/A6,3
- 16, WALL MOUNTED LIGHT FIXTURE, SEE ELECTRICAL DRAWINGS
- 17, LED LIGHT BAND, SEE ELECTRICAL DRAWINGS
- 18. SES PANEL, SEE ELECTRICAL DRAWINGS
- 19. ELECTRICAL OUTLETS, SEE ELECTRICAL DRAWINGS
- 20. HOSE BIBB, SEE PLUMBING DRAWINGS
- 21. SIGNAGE BY OTHERS, UNDER A SEPARATE PERMIT

BAYLAND BUILDINGS

(920) 498-9300 FAX (920) 498-3033 www.baylandbuildings.com

DESIGN & BUILD GENERAL CONTRACTOR

OF PLYMOUTH, WISCONSIN; COUNTY OF: SHEBOYGAN COFFEE **TER'S** 00 Ö S

PROPOSED BUILDING FOR: CITY SCALE VERIFICATION THIS BAR MEASURES 1" ON ORIGINAL ADJUST SCALE ACCORDINGLY.

NOTICE OF COPYR	IGHT COPPRIGHTED AND ANE SUBJECT TO COPP
PROTECTION AS A	N "ARCHITECTURAL WORK" UNGER SEC. 1024
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COMPENSATIONS	D BAYLAND BUILDINGS, INC.

JOB NUMBE	ER: 22-5223
SALES REP	:
T	OM AMBROSIUS
(920) 371-2544
DRAWN BY:	
DATE:	12-21-22
REVISIONS:	
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SUED FOR	R:
X	PRELIMINARY
	BID SET
	CONSTRUCTIO

SHEET

A3.1

SCOOTER'S COFFEE 2793 EASTERN AVENUE

CITY OF PLYMOUTH SHEBOYGAN COUNTY





SITE STATS

ZONING DESIGNATION: HIGHWAY BUSINESS (B-3)

FUTURE LAND USE: COMMERCIAL

BUILDING SETBACK REQUIREMENTS: MET

50 FOOT FRONT

40 FOOT REAR

20 FOOT SIDE

BUILDING HEIGHT REQUIREMENTS 35 FOOT MAX


19 FOOT PROPOSED

LOT AREA: 0.54 AC

PARKING REQUIREMENTS

ONE STALL PER 200 SF = 888 SF/200 = 5 STALLS

PROVIDED: 7 STALLS

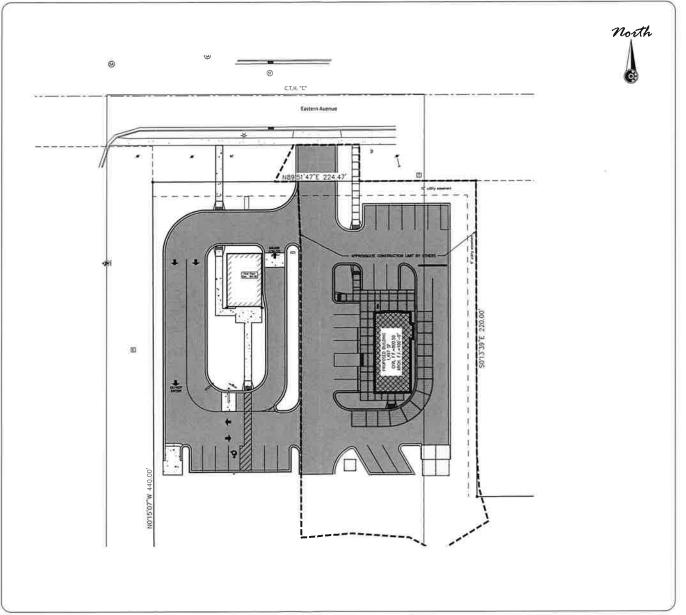



Mau & Associates

LAND SURVEYING & PLANNING CIVIL & WATER RESOURCE ENGINEERING

Phone: 920-434-9670 Fax: 920-434-9672

PROJECT INFORMATION

OWNER (CURRENT):

PLANKVIEW GREEN DEVELOPMENT LLC

SCOOTER'S COFFEE 2793 EASTERN AVENUE

PROJECT DESCRIPTION:

SCOOTER'S COFFEE DRIVE-THRU

PROJECT LOCATION:

2793 EASTERN AVENUE

PARCEL NUMBER(S):

59271821072

LOT 1 CSM V26 P269-271 #1997383 BEING PRT LOT 2 CSM V24 P276-278 #1902946 - PRT NW NE, SEC 26

CONTACT INFORMATION

OWNER (CURRENT):

PLANKVIEW GREEN DEVELOPMENT LLC W5073 COUNTY ROAD O PLYMOUTH, WI 53073

OWNER (FUTURE):

HART FAMILY COFFEE CONTACT: TROY HART 10 11TH STREET SE SPENCER, IA 51301 TROY.HART@HARTFAMILY HOTELS.COM

ENGINEER:

MAU & ASSOCIATES, LLP CONTACT: MATHEW LITCHFIELD, P.E. 400 SECURITY BLVD. GREEN BAY, WI 54313 PH.: 920-434-9670

SHEET INDEX:

C1.0 TITLE SHEET

C2.0 NOTES

C3.0 EXISTING SITE AND DEMOLITION PLAN

C4.0 SITE PLAN

C5.0 EROSION CONTROL PLAN

C6.0 GRADING PLAN

C6.1 CURB & GUTTER PLAN

C7.0 SITE UTILITY PLAN

C8.0 DETAILS 1

C8.1 DETAILS 2

10/06/22 PROJECT NO. B-13522 SHEET NO. C1.0 S-3649

DATE:

RESPONSE ACTIONS IN THE EVENT OF A SPILL OR RELEASE

IMMEDIATELY TAKE THE FOLLOWING MEASURES TO KEEP THE SPILL FROM ENTERING SEWER OR STORM DRAINS, SPREADING OFF SITE, OR AFFECTING HUMAN

STOP, CONTAIN, AND CLEAN UP CHEMICAL SPILL IF

- THE SPILLED CHEMICAL AND ITS HAZARDOUS PROPERTIES HAVE BEEN IDENTIFIED
- THE SPILL IS SMALL AND EASILY CONTAINED.
- RESPONDER IS AWARE OF THE CHEMICALS' HAZARDOUS PROPERTIES

IF SPILL OR RELEASE CANNOT BE CONTROLLED OR INJURIES HAVE OCCURRED DUE TO THE RELEASE THE FOLLOWING PROCEDURES SHOULD BE IMPLEMENTED:

- SUMMON HELP OR ALERT OTHERS OF THE RELEASE
- EVACUATE IMMEDIATE AREA, PROVIDE CARE TO INJURED, CALL 911
- IF POTENTIAL FOR FIRE OR EXPLOSION CALL 91'
- RESPOND DEFENSIVELY TO ANY LINCONTROLLED SPILLS
- USE PROTECTIVE EQUIPMENT
- ATTEMPT TO STOP SOURCE OF RELEASE (IF SAFE TO DO SO) PROTECT DRAINS BY USE OF ABSORBENT, BOOMS OR DRAIN
- COVERS (IF SAFE TO DO SO) NOTIFY ONSITE EMERGENCY CONTACT(S)

Legend

1" IRON PIPE FOUND

■ COMPUTED POINT

PK NAIL FOUND

PK NAIL SET

Ø CUT + FOUND

@ 3/4" IRON PIPE FOUND

BROWN COUNTY MONUMENT

() RECORDED AS BEARING / DISTANCE

@ 2" IRON PIPE FOUND

---- UNDERGROUND FIBER OPTIC LINE

F FIRER OPTIC PEDESTAL

(F) FIBER OPTIC MANHOLI

GROUND LIGHT

→ LIGHT POLE

- COORDINATE RESPONSE ACTIVITIES WITH LOCAL EMERGENCY
- BE PREPARED TO PROVIDE MSDS INFORMATION TO EMERGENCY PERSONNEL
- · NOTIFY APPROPRIATE AGENCY IF RELEASE HAS ENTERED THE ENVIRONMENT

POWER POLE

---- ANCHOR WIRE

OVERHEAD WIRES

EXISTING ASPHALT

EXISTING BUILDING

CONCRETE

GRAVEL

PROPOSED ASPHALT

PROPOSED BUILDING

A HANDICAP PARKING SPACE

(MW) MONITORING WELL

COOO ROCK WALL

(WE) WELL

SHRUE

CONCRETE CURB & GUTTÉR LINE

SPILL PREVENTION AND EMERGENCY RESPONSE PLAN:

EMERGENCY CONTACTS BAYLAND BUILDINGS INC (920) 498-9300

(920) 449-7000

EMERGENCY RESPONSE CONTACTS FIRE/PARAMEDICS/POLICE 911 FIRE NON-EMERGENCY LINE (920) 893-1331 COUNTY HEALTH DEPARTMENT (920) 459-3207 DNR SPILL HOTLINE 1-800-943-0003

LOCAL EMERGENCY MEDICAL FACILITY AURORA URGENT CARE 2600 KILEY WAY PLYMOUTH, WI 53073

SPILL PREVENTION HAZARDOUS SUBSTANCE MANAGEMENT: ALL HAZARDOUS SUBSTANCES, INCLUDING CHEMICAL WASTES, ARE TO BE MANAGED IN A WAY THAT PREVENTS RELEASE.

CONSTRUCTION SITE EROSION CONTROL

THE CONTRACTOR IS RESPONSIBLE FOR INSTALLING AND MAINTAINING EROSION AND SEDIMENT CONTROL MEASURES. ALL EROSION AND SEDIMENT CONTROL PRACTICES SHALL BE ACCORDANCE WITH THE WISCONSIN DEPARTMENT OF NATURAL RESOURCES TECHNICAL STANDARDS AND IF NO STANDARD EXISTS THE WISCONSIN CONSTRUCTION SITE BEST MANAGEMENT PRACTICE HANDBOOK (CURRENT EDITION) SHALL BE REFERENCED. EROSION AND SEDIMENT CONTROL PRACTICES SHALL BE IN PLACE PRIOR TO DISTURBING THE SITE. CONTRACTORS SHALL MINIMIZE THE DURATION AND SIZE OF DISTURBED AREAS TO THE MAXIMUM EXTENT PRACTICABLE, EROSION AND SEDIMENT CONTROL PRACTICES PROPOSED FOR THIS PROJECT ARE DESCRIBED AS FOLLOWS:

SEDIMENT TRACKING FROM CONSTRUCTION SITE:

- STONE TRACKING PAD(S) TECHNICAL STANDARD 1057 STONE TRACKING PADS WILL BE INSTALLED AT ENTRANCES SHOWN ON THE SITE.
- TRACKING PADS SHALL BE IN PLACE PRIOR TO LAND DISTURBING ACTIVITIES. WASH WATER FROM VEHICLE AND WHEEL WASHING SHALL BE TREATED BEFORE ENTERING WATERS OF THE STATE.
- STREET SWEEPING/CLEANING

SEDIMENT TRACKED FROM THE CONSTRUCTION SITE SHALL BE CLEANED UP AT THE END OF EACH WORK DAY UNLESS THE SEDIMENT PRESENTS A HAZARD. SEDIMENT PRESENTING A HAZARD MUST BE CLEANED UP IMMEDIATELY.

SEDIMENT CARRIED OFF-SITE BY OVERLAND FLOW OR RUNOFF:

- SILT FENCE TECHNICAL STANDARD 1056
- SILT FENCE WILL BE INSTALLED DOWN-SLOPE OF ALL DISTURBED AREAS OF THE SITE, THE FENCE SHALL BE INSTALLED ALONG THE CONTOURS AND BE IN-PLACE PRIOR TO LAND DISTURBING ACTIVITIES.
- SEEDING TECHNICAL STANDARD 1059: MULCHING TECHNICAL STANDARD 1058 DISTURBED AREAS OF THE SITE SHALL BE SEEDED AND MULCHED AS SOON AS THEY ARE BROUGHT TO FINISHED GRADE, IN ADDITION, ANY STOCK PILES IN PLACE FOR 7 DAYS OR MORE SHALL BE SEEDED AND MULCHED.
- NON-CHANNEL EROSION MAT TECHNICAL STANDARD 1052

EROSION CONTROL MAT SHALL BE PLACED AS SHOWN ON THE PLANS, AND/OR AS DETERMINED IN THE FIFLD. TO PROTECT THE DISTURBED SLOPES FROM EROSION. NON-CHANNEL EROSION MAT SHALL BE INSTALLED AS SOON AS THE SLOPE HAS BEEN BROUGHT TO FINISHED GRADE.

CONSTRUCTION SITE DIVERSION - TECHNICAL STANDARD 1066

WHERE POSSIBLE, THE SITE WILL BE GRADED SUCH THE RUNOFF FROM UNDISTURBED AREAS IS ROUTED AROUND DISTURBED AREAS OF THE SITE.

SEDIMENT CARRIED OFF-SITE BY DEWATERING OPERATIONS:

- DEWATERING TECHNICAL STANDARD 1061
- DEWATERING IS NOT ANTICIPATED FOR THIS PROJECT. IF IT IS REQUIRED, DEWATERING SHALL BE IN ACCORDANCE WITH THE DEWATERING TECHNICAL STANDARD. ANY NECESSARY PERMITS SHALL BE OBTAINED PRIOR TO DEWATERING OPERATIONS TAKE PLACE...

SEDIMENT ENTERING STORM DRAIN INLETS:

- STORM DRAIN INLET PROTECTION TECHNICAL STANDARD 1060
- ALL INLETS, PROPOSED AND EXISTING, ACCEPTING RUNOFF FROM DISTURBED AREAS OF THE SITE SHALL HAVE INLET PROTECTION INSTALLED PRIOR TO LAND DISTURBING ACTIVITY WITHIN THE AREA DISCHARGING TO THE INLET.

SEDIMENT BEING CARRIED OFF-SITE BY WIND:

- DUST CONTROL TECHNICAL STANDARD 1068
- WHEN REQUIRED, DUST CONTROL MEASURES SHALL BE EMPLOYED TO PREVENT DUST FROM BLOWING OFF-SITE.

CONCRETE WASHOUT

. CONCRETE WASHOUT SHALL BE COLLECTED AND RETAINED, BOTH WATER AND CONCRETE, IN LEAK PROOF CONTAINERS WASHOUT CAN BE RECYCLED OR REUSED SEE http://water.epa.gov/polwaste/npdes/swbmp/upload/concretewashout.pdf FOR

- ALL CLEARING, GRADING, GRAVELING, PAVING, AND RESTORATION SHALL BE DONE IN ACCORDANCE WITH THE WISCONSIN DOT STANDARD SPECIFICATIONS FOR HIGHWAY AND STRUCTURE CONSTRUCTION, CURRENT EDITION.
- 2, A COPY OF THE EROSION CONTROL PLAN SHALL BE KEPT ON SITE AT ALL TIMES.
- 3. EROSION CONTROL METHODS SHALL BE IMPLEMENTED, AS DIRECTED BY THE ENGINEER, PRIOR TO AND DURING CONSTRUCTION, TO CONTROL WATER POLLUTION, EROSION, AND SILTATION. ALL EROSION CONTROL MEASURES SHALL BE INSTALLED AND MAINTAINED IN ACCORDANCE WITH THE WIDNR TECHNICAL STANDARDS.
- CONTRACTOR IS RESPONSIBLE FOR CONTACTING DIGGERS HOTLINE FOR THE LOCATION OF THE UTILITIES.
- 5. CONTRACTOR IS RESPONSIBLE FOR REMOVAL AND DISPOSAL OF ALL STUMPS
- 6. EXCESS TOPSOIL SHALL BE STOCKPILED ON THE SITE WITH THE PROPER EROSION CONTROL AT A LOCATION ACCEPTABLE TO THE OWNER.
- 7. CONTRACTOR SHALL DISPOSE OF ALL WASTE AND EXCESS MATERIAL AT AN APPROVED LOCATION.
- 8. CONTRACTOR SHALL PROTECT ALL PROPERTY IRONS. A LICENSED LAND SURVEYOR. THE CONTRACTORS EXPENSE, SHALL REPLACE ANY PROPERTY IRONS REMOVED DURING CONSTRUCTION.
- 9. EXISTING UTILITY INVERTS BASED ON EXCEL ENGINEERING PLANS DATED JUNE 9, 2022. CONTRACTOR SHALL FIELD VERIFY EXISTING MATERIAL, LOCATION, AND SIZE.

INSPECTION AND MAINTENANCE

THE CONTRACTOR IS RESPONSIBLE FOR INSPECTION AND MAINTENANCE OF EROSION AND SEDIMENT CONTROLS UNTIL THE CONSTRUCTION SITE IS PERMANENTLY STABILIZED WITH A DENSE GRASS COVER. THE CONTRACTOR SHALL INSPECT EROSION AND SEDIMENT CONTROLS WEEKLY AND WITHIN 24 HOURS AFTER A RAINFALL EVENT OF 0.5 INCHES OR GREATER. THE CONTRACTOR SHALL INSPECT EROSION AND SEDIMENT CONTROLS FOR STRUCTURAL DAMAGE, SEDIMENT ACCUMULATION, OR ANY OTHER UNDESIRABLE CONDITION: THE CONTRACTOR SHALL REPAIR DAMAGED STRUCTURES PRIOR TO THE END OF EACH WORKING DAY, SEDIMENT SHALL BE REMOVED FROM THE STRUCTURE WHEN THE DEPTH OF SEDIMENT HAS ACCUMULATED TO ONE HALF THE HEIGHT OF THE DEVICE OR AS REQUIRED BY THE APPLICABLE WISCONSIN DEPARTMENT OF NATURAL RESOURCES TECHNICAL STANDARD (CURRENT EDITION).

THE CONTRACTOR SHALL SLIMMARIZE WEEKLY INSPECTION AND MAINTENANCE ACTIVITIES ON A WEEKLY INSPECTION REPORT THAT IS AVAILABLE THROUGH THE WONR.

THE WEEKLY INSPECTION REPORT SHALL INCLUDE THE FOLLOWING MINIMUM

NAME OF INDIVIDUAL PERFORMING INSPECTION;

DATE, TIME, AND PLACE OF INSPECTION

A DESCRIPTION OF THE CONSTRUCTION PHASE

A DESCRIPTION OF EROSION AND SEDIMENT CONTROL INSTALLATIONS;

A DESCRIPTION OF EROSION AND SEDIMENT CONTROL MAINTENANCE ACTIVITIES; AND AN ASSESSMENT OF EROSION AND SEDIMENT CONTROL CONDITIONS,

THE CONTRACTOR SHALL PROMPTLY FURNISH THE ORIGINAL WEEKLY INSPECTION

REPORTS TO THE OWNER OWNER'S REPRESENTATIVE OR WISCONSIN DEPARTMENT OF NATURAL RESOURCES WHEN REQUESTED. THE CONTRACTOR SHALL KEEP A COPY OF THE APPROVED EROSION & SEDIMENT CONTROL PLAN PERMITS AND WEEKLY INSPECTION REPORTS ON-SITE AT ALL TIMES.

ALL WASTE FROM THE CONSTRUCTION SITE SHALL BE PROPERLY DISPOSED OF AND NOT BE ALLOWED TO ENTER THE STORM SEWER SYSTEM, DRAINAGE SYSTEM, OR OTHER ENVIRONMENTALLY SENSITIVE AREAS LOCATED WITHIN THE CONSTRUCTION SITE.

SEQUENCE OF CONSTRUCTION

- INSTALL TRACKOUT PROTECTION AND SILT FENCE AS SOON AS PRACTICABLE PERFORM STREET SWEEPING AS NEEDED.
- B. CONTACT THE CITY OF PLYMOUTH TO NOTIFY THEM THAT SITE GRADING IS TO BEGIN AND INITIAL EROSION CONTROLS ARE INSTALLED.
- C. STRIP AND STOCKPILE TOPSOIL
- CONSTRUCT BUILDING AND INSTALL UTILITIES
- E. GRADE AND CONSTRUCT PARKING LOT, USE EXISTING PARKING LOT AS CONSTRUCTION STAGING AREA.
- F. SALVAGE SUITABLE MATERIAL FOR FILL MATERIAL DISPOSE OF NON-SUITABLE OR EXCESS SOILS AT A PERMITTED OFF-SITE LOCATION.
- G: PERFORM STREET SWEEPING AND TEMPORARY MULCHING/SEEDING AS NEEDED AND REQUIRED.
- G. COMPLETE FINE GRADING AND LANDSCAPING PERMANENTLY STABILIZE EACH AREA OF THE CONSTRUCTION SITE WITH TOPSOIL, SEED, FERTILIZE, AND MULCH AS SOON AS PRACTICABLE AFTER FINAL GRADING.

AUGUST 2023

H. REMOVE AND DISPOSE OF EROSION AND SEDIMENT CONTROL MEASURES WITHIN 30 DAYS OF FINAL SITE STABILIZATION (I.E. SILT FENCE), VEGETATION SHALL ACHIEVE 70% GROWTH TO BE CONSIDERED STABILIZED. 2

Associates Eying & Planning Esource engineering $\mathcal{L}^{\tilde{p}}$ B [au d AND SUR WATER!

DESIGNED BY

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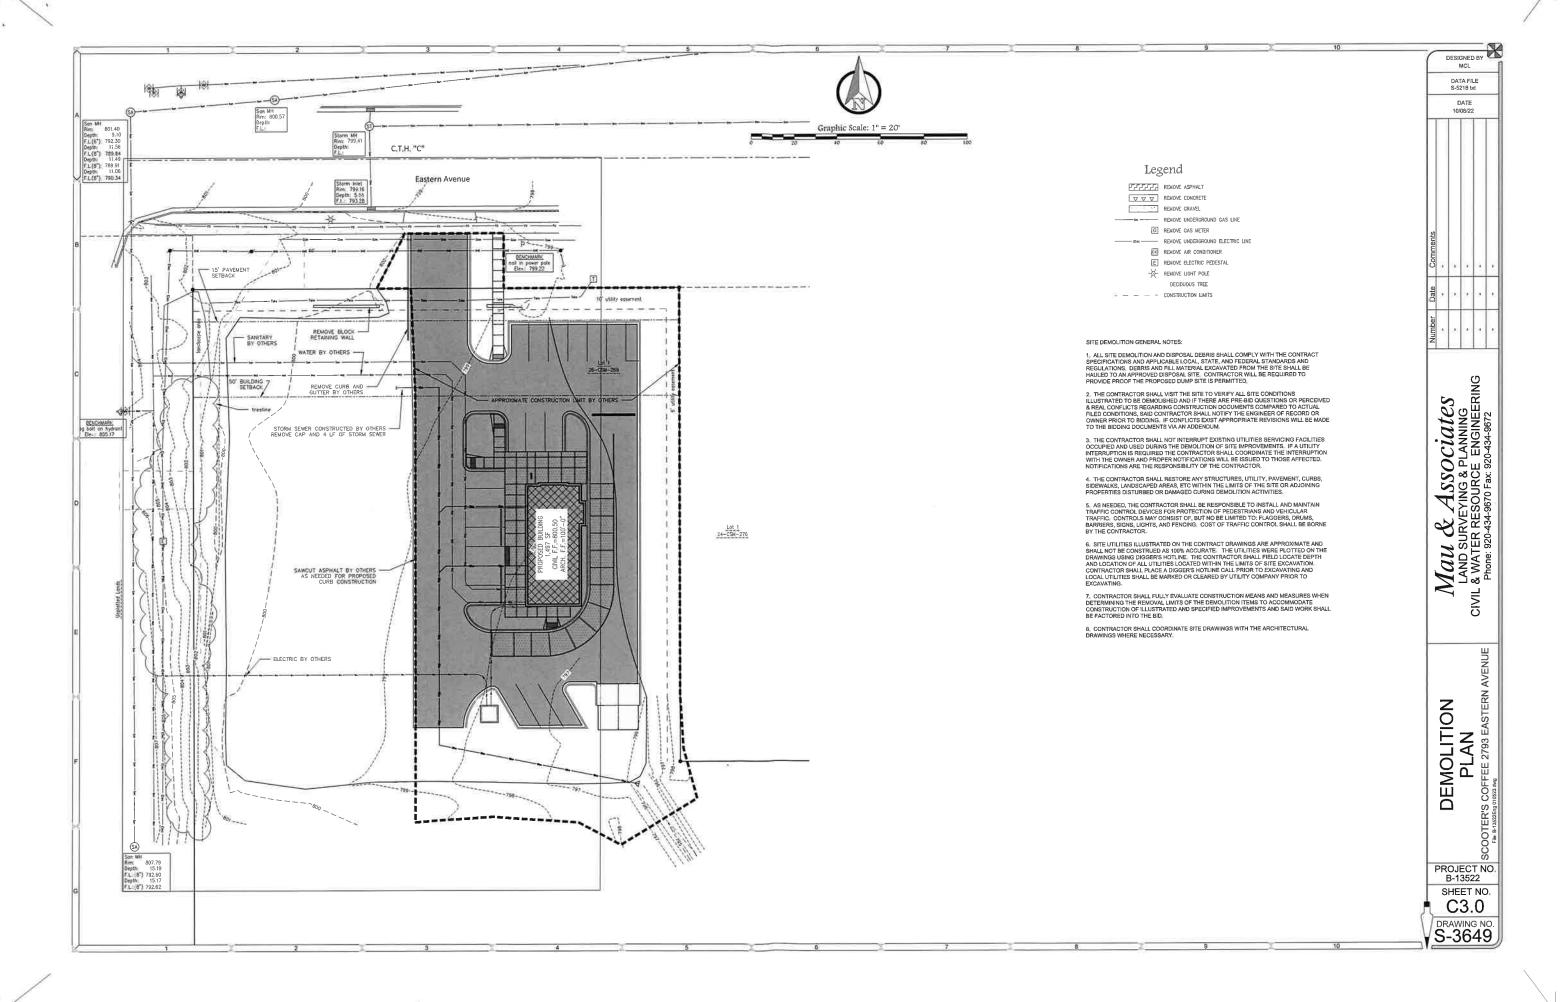
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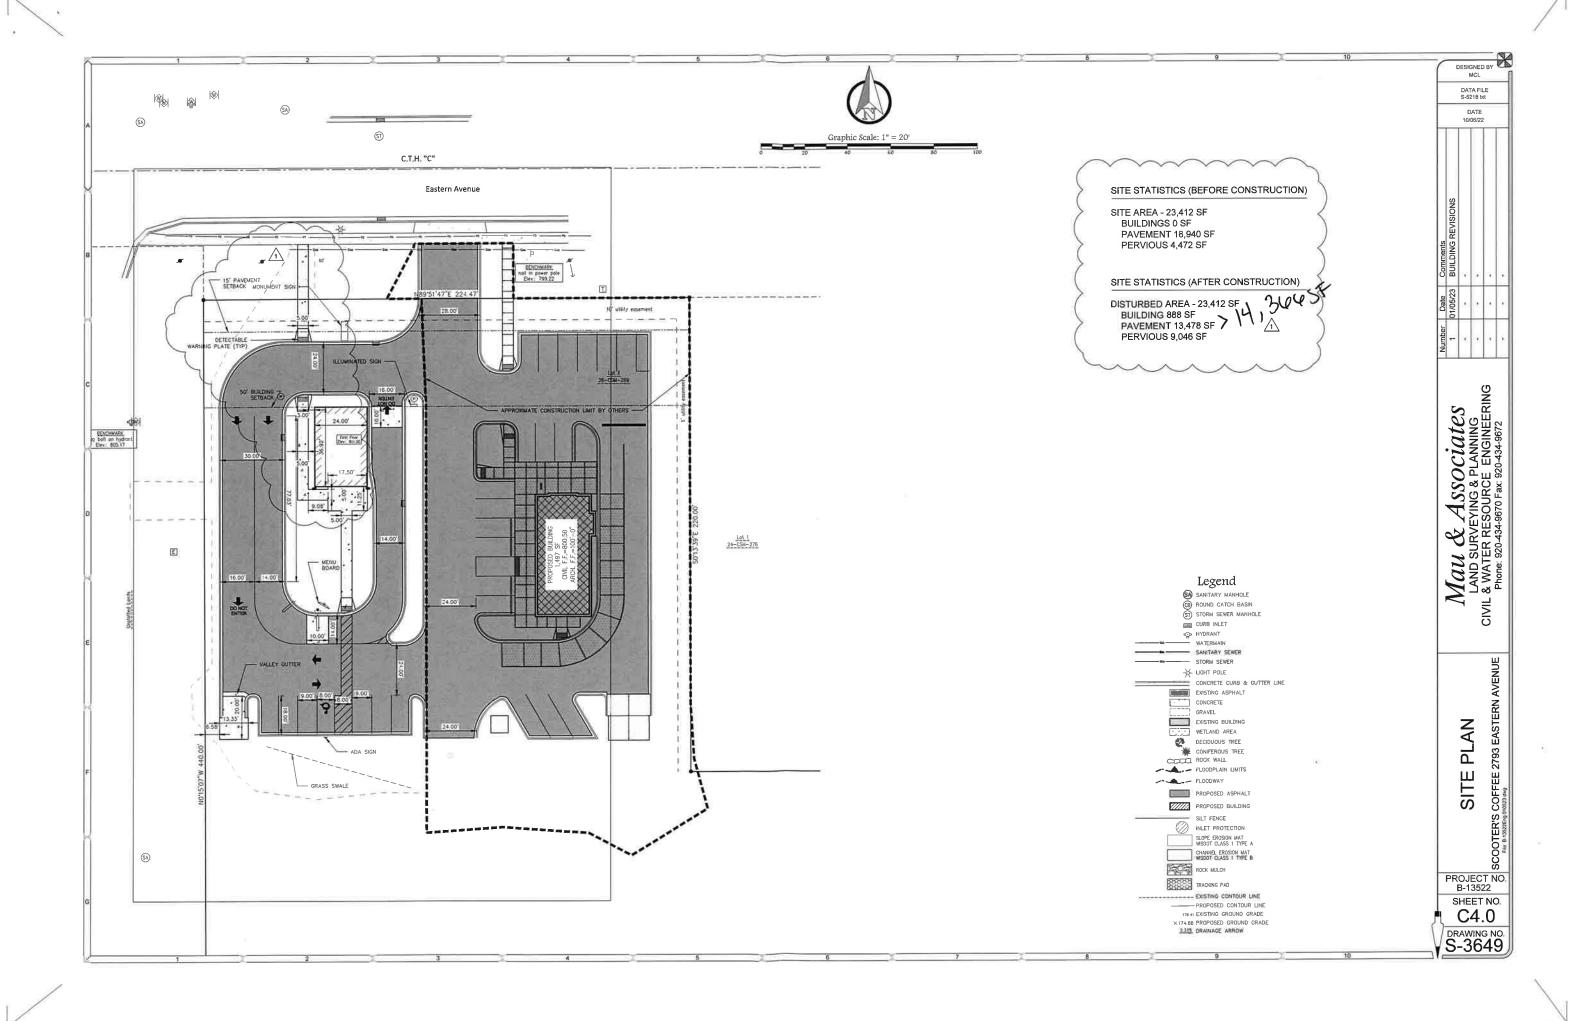
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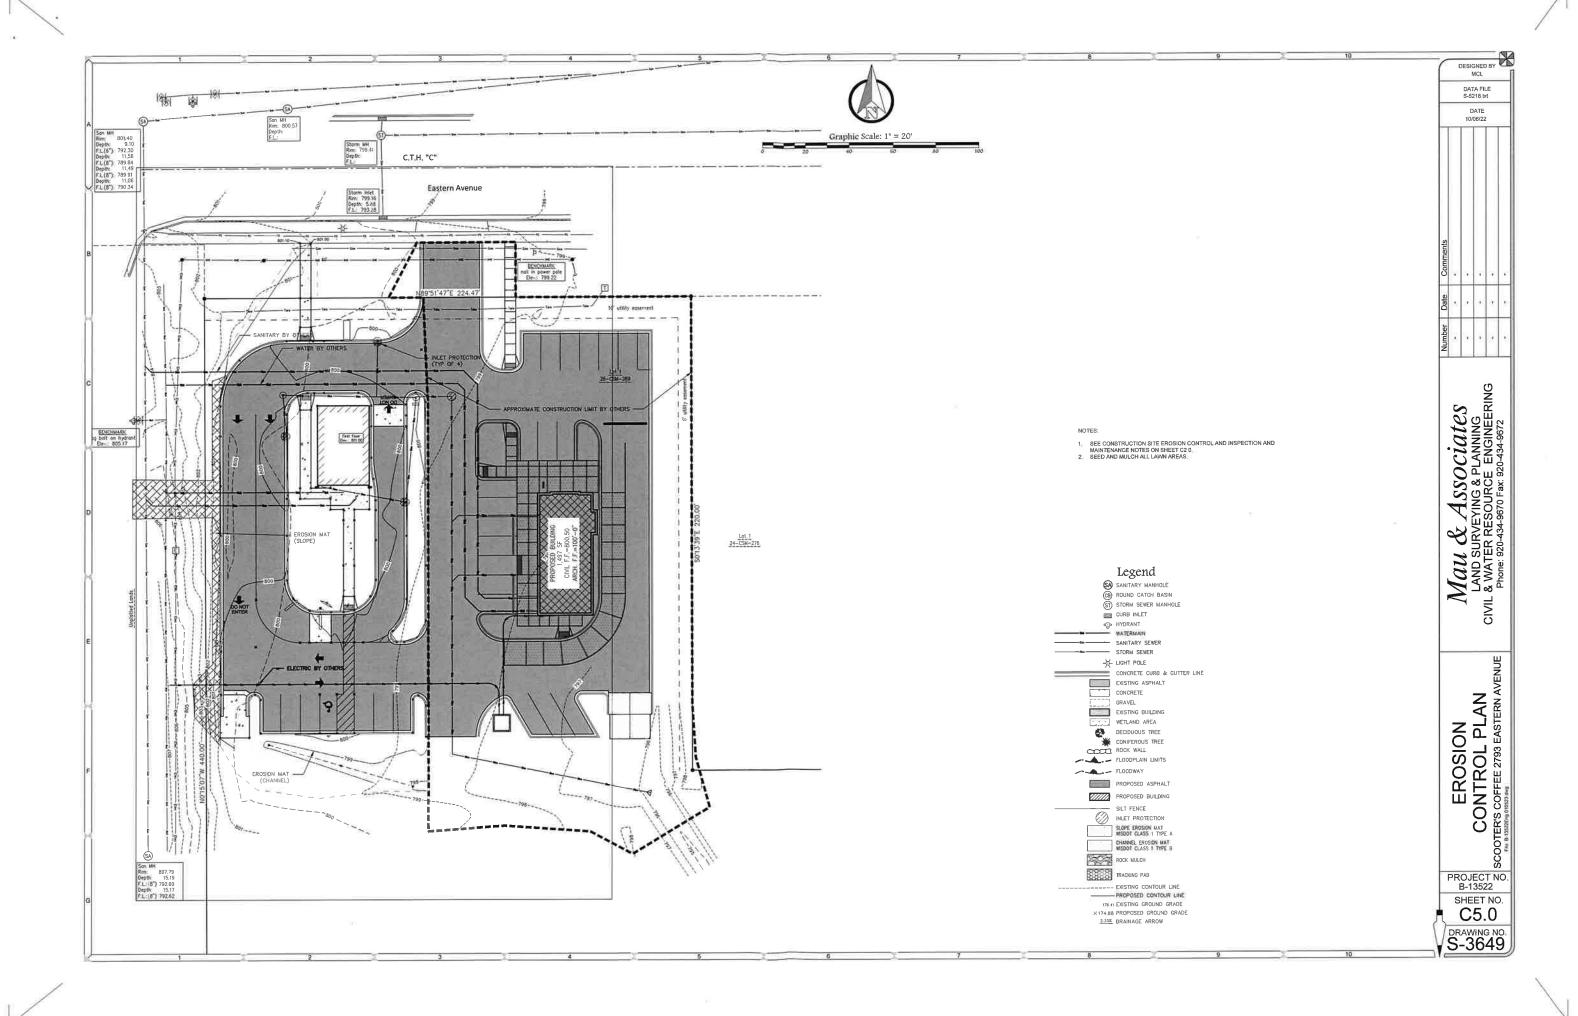
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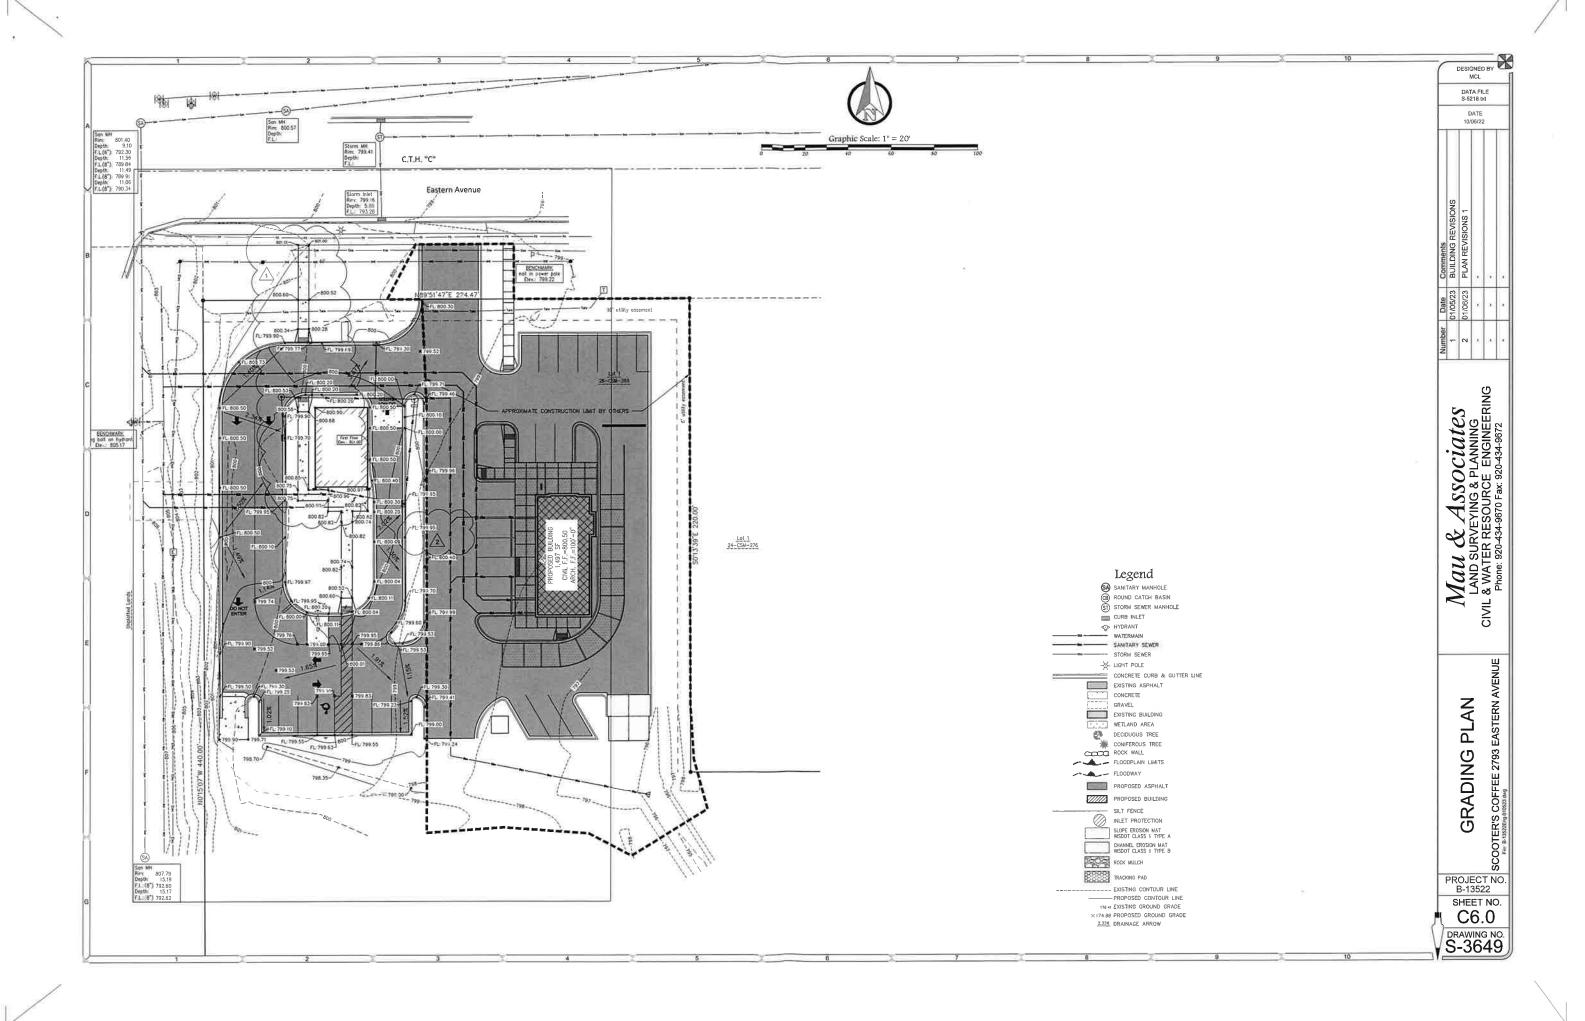
DRAWING NO S-3649


NO ACCESS WETLAND AREA ---- FLOODPLAIN LIMITS (CB) ROUND CATCH BASIN ST STORM SEWER MANHOLE FLOODWAY CURB INLET - SILT FENCE INLET PROTECTION STORM SEWER LINE SANITARY CLEANOUT SA) SANITARY SEWER MANHOLE SLOPE EROSION MAT WISDOT CLASS 1 TYPE A SANITARY SEWER LINE CHANNEL EROSION MAT WISDOT CLASS 1 TYPE 8 (W) WATER MANHOLE P HYDRANT RIP RAP SIZE AND QUANTITY PER PLAN - WATERMAIN WWW WATER VALVE TRACKING PAD WATER VALVE - CURB STOP G GAS VALVE EXISTING CONTOUR LINE PROPOSED CONTOUR LINE UNDERGROUND GAS LINE G GAS METER 176.4) EXISTING GROUND GRADE UNDERGROUND TELEPHONE LINE ×174.88 PROPOSED GROUND GRADE T TELEPHONE PEDESTA 2.33% DRAINAGE ARROW (T) TELEPHONE MANHOLI - FENCE LINE UNDERGROUND ELECTRIC LINE - CUARD RAI ar conditioner TR ELECTRIC TRANSFORMER FLAG POLE E ELECTRIC PEDESTAL (E) ELECTRIC MANHOLE DECIDUOUS TREE CONIFEROUS TREE (H) HANDHOLE BOX O TRAFFIC LIGHT Call CABLE TV PEDESTAL












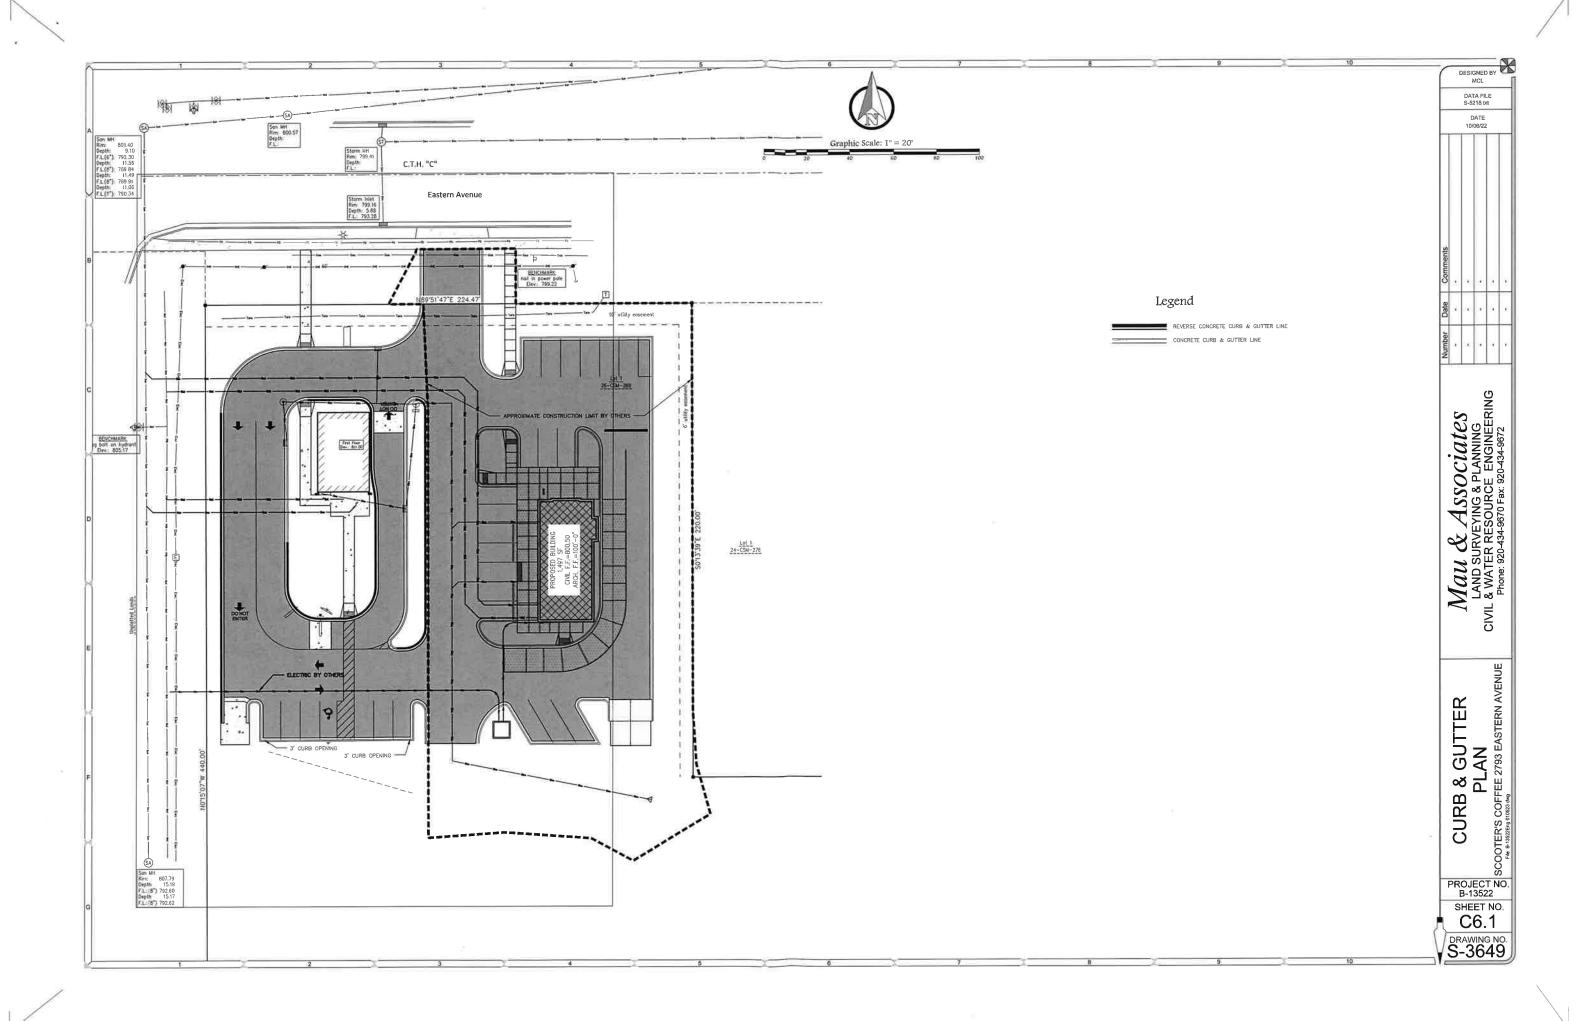

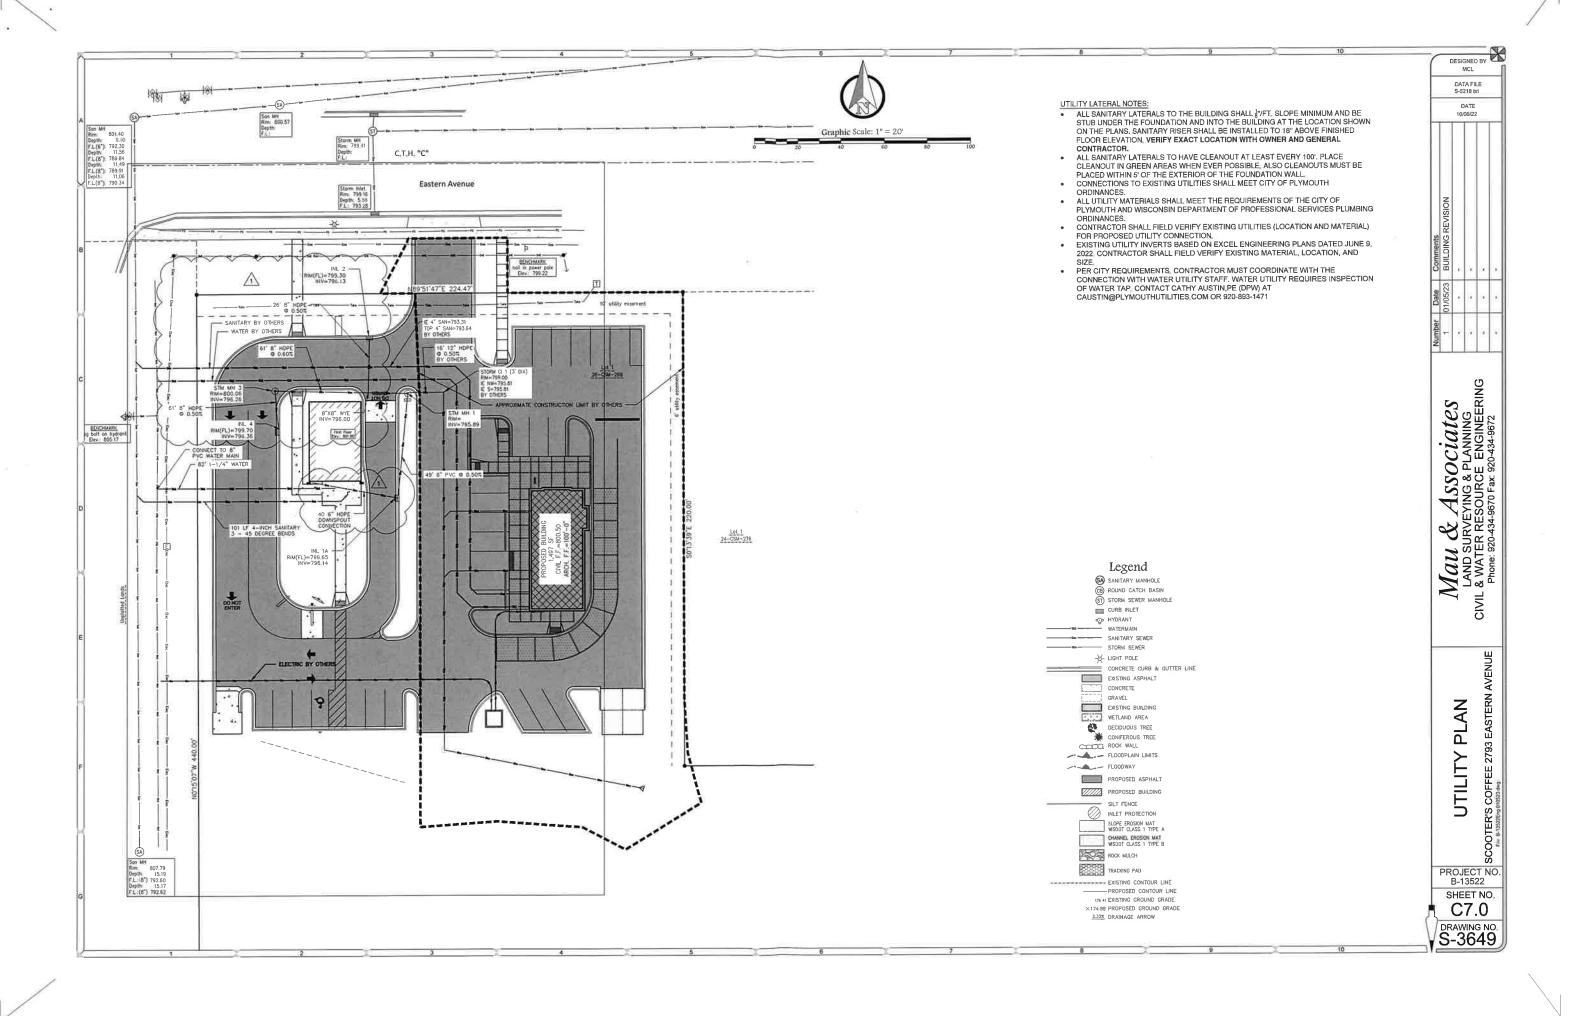

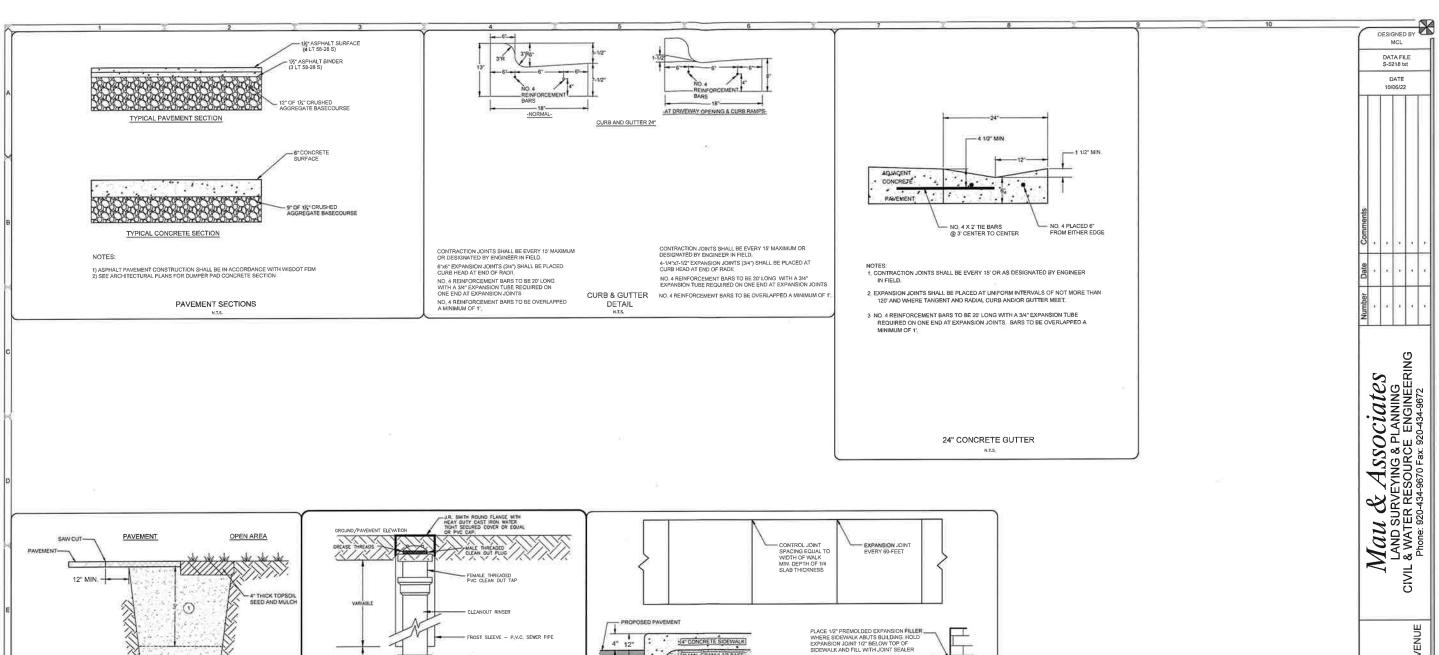

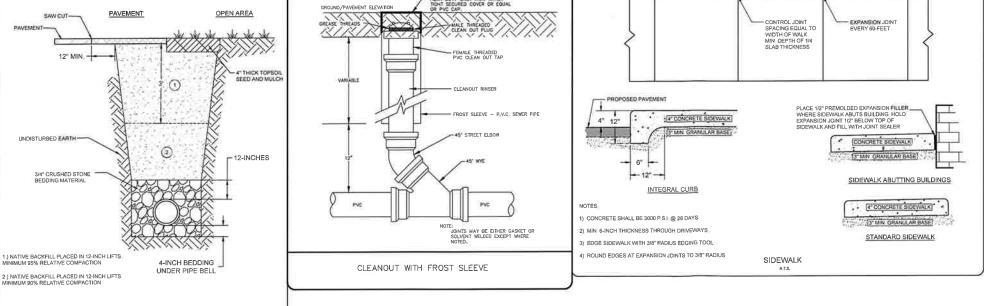

1.) ALL PIPE SHALL BE INSTALLED IN ACCORDANCE WITH ASTM DESGINATION D 2321

2.) IF RUNNING, CAVING OR SQUEEZING SOILS ARE ENCOUNTERED NOTIFY THE ENGINEER IMMEDIATELY TO DETERMINE WHAT CORRECTIVE MEASURES SHALL BE TAKEN

TYPICAL TRENCH

3.) EACH LIFT OF BACKFILL MATERIAL SHALL BE MECHANICALLY COMPACTED TO THE REQUIRED DENSITY PRIOR TO PLACING SUCCEEDING LIFTS OF BACKFILL.

DETAILS


CIVIL


SCOOTER'S COFFEE 2793 EASTERN AVENUE


PROJECT NO. B-13522 SHEET NO.

C8.0

DRAWING NO. S-3649

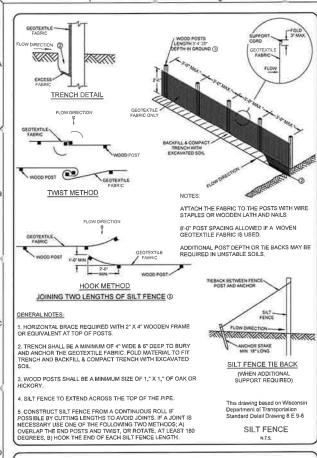

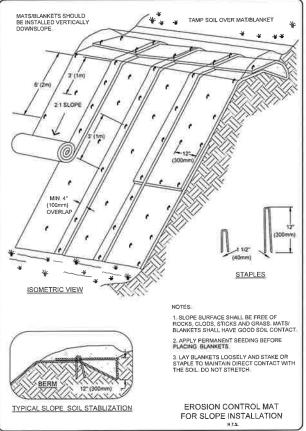

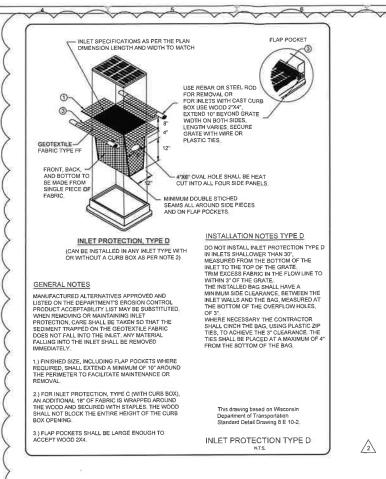

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MCL

DATA FILE S-5218 txl DATE 10/06/22

CIVIL

SCOOTER'S COFFEE 2793 EASTERN 2 S **DETAIL**(

PROJECT NO. B-13522 SHEET NO. C8.1

DRAWING NO. S-3649